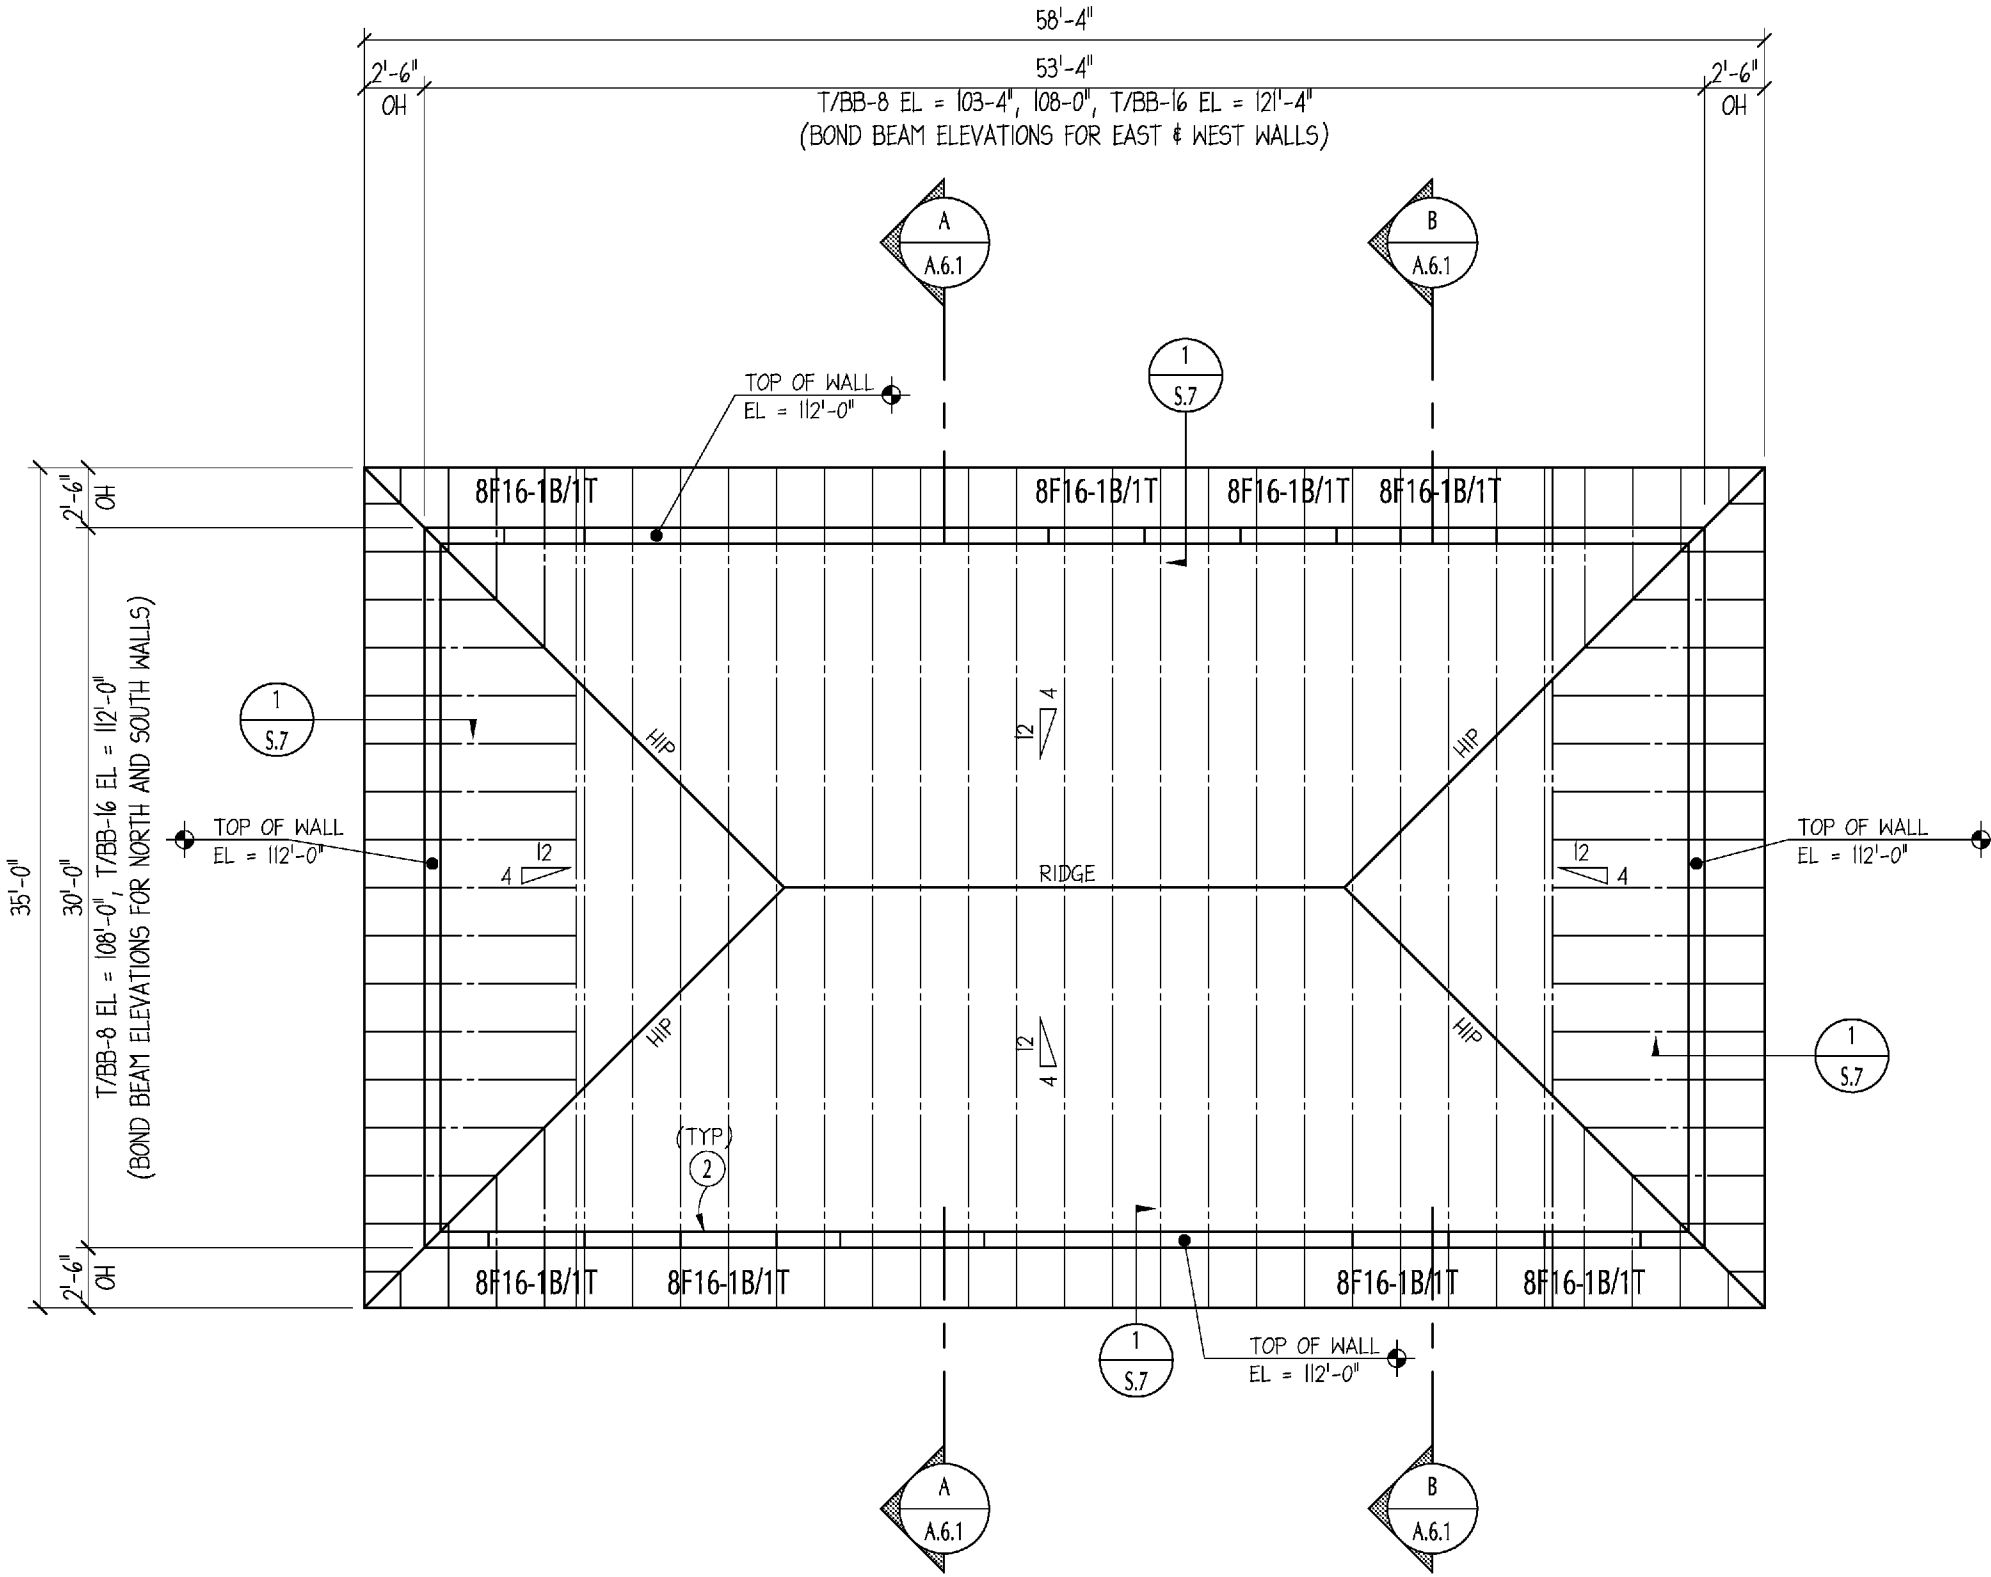


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ANY MODIFICATIONS TO THESE PLANS OR RE-USE OF THESE PLANS MUST BE APPROVED BY AND SIGNED BY THE ARCHITECT.

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ROOF FRAMING PLAN NOTES



- 1 ROOF SHEATHING SHALL BE 7/16" OSB W/ A 24 / 16 SPAN RATING. LAY SHEATHING UNLOCKED IN A RUNNING BOND PATTERN PERPENDICULAR TO THE ROOF TRUSSES. FASTEN W/ 8d X 1 1/2" PENETRATION COMMON NAILS @ 6" OC AT PANEL EDGES & @ 12" OC ELSEWHERE.
- 2 SEE DETAIL 1/5.6 FOR LINTEL DETAILS.
- 3 FOR BOND BEAM DETAILS SEE 2/5.6.
- 4 PRE-FAB, PRE-ENG WOOD ROOF TRUSSES @ 24" OC MAX TO BE DESIGNED AND ENGINEERED BY A FLORIDA LICENSED ENGINEER.
- 5 ALTERNATE - STANDING SEAM ROOF PANELS & THEIR CONNECTIONS SHALL BE PRE-ENGINEERED. CALCULATIONS & SHOP DRAWINGS SHALL BE PREPARED, SIGNED & SEALED BY A FLORIDA REGISTERED ENGINEER. SEE 1/5.3.1 FOR GROSS UPLIFT LOADS.

ROOF FRAMING PLAN

VOL ALT #03, ALT #08, ALT #09 & ALT #17

1/8" = 1'-0"

MAIN BUILDING

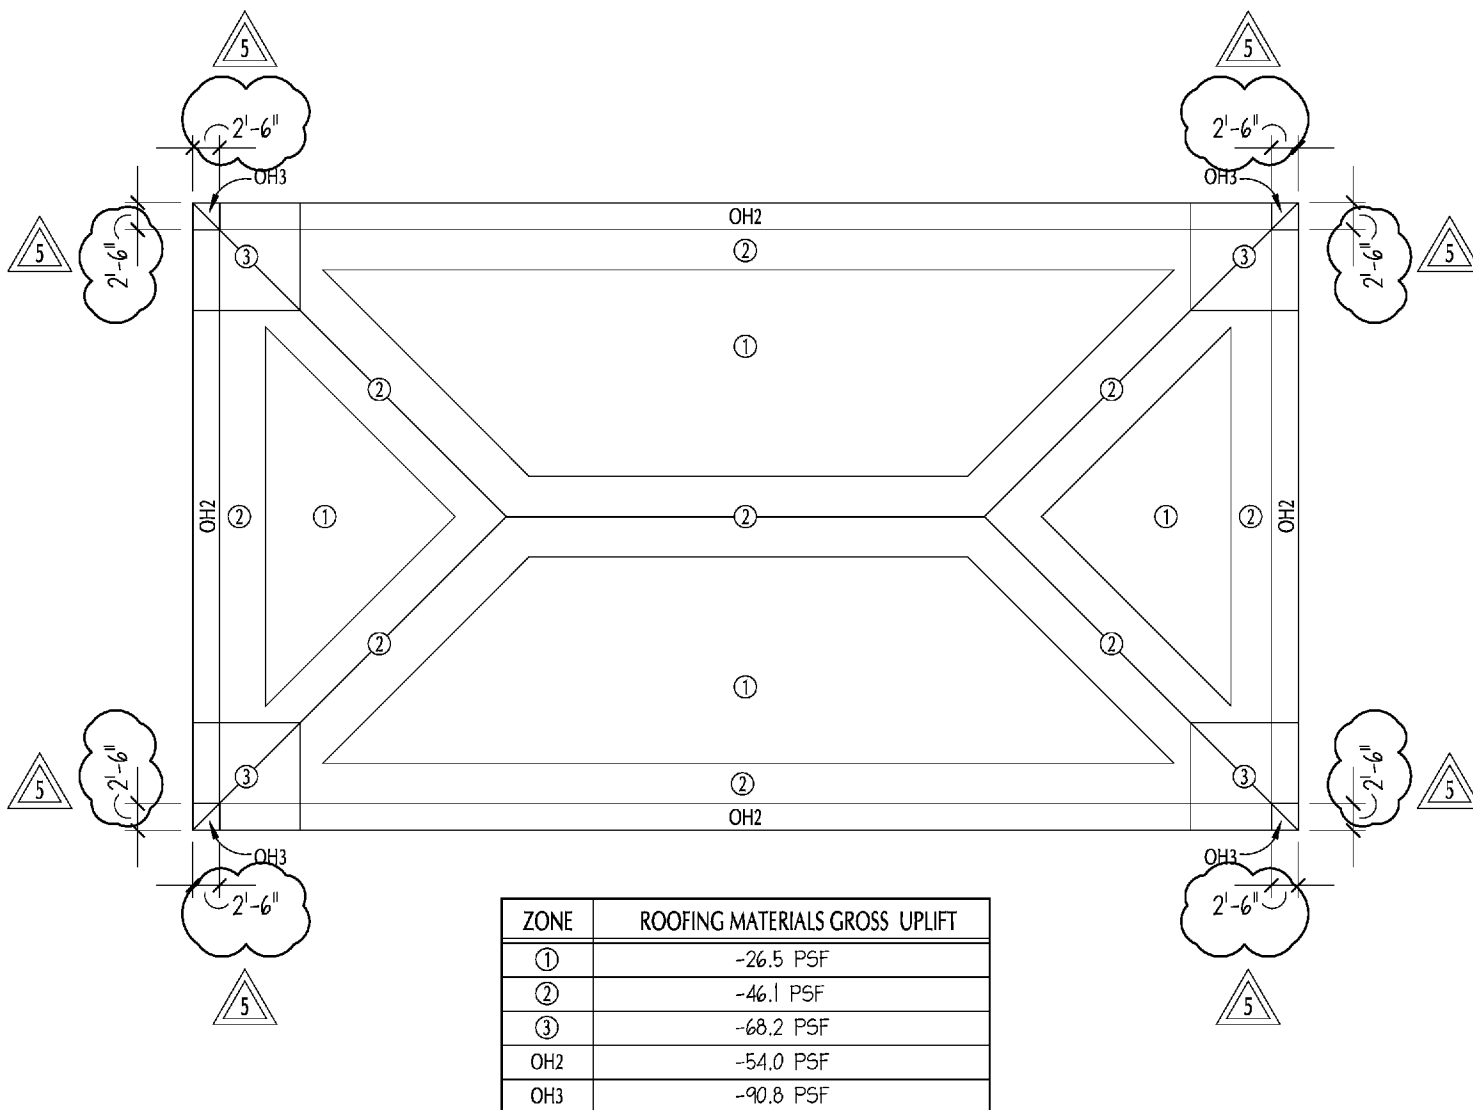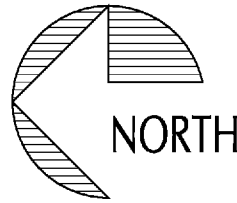

GROSS UPLIFT DIAGRAM

NOT TO SCALE

1
S.3.1

SOUTHARD ENGINEERING, INC.

PAUL
STRESING
ASSOCIATES
INC.
ARCHITECTURE
INTERIOR DESIGN

CITY OF NEWBERRY
NATIONS BASEBALL PARK
NEWBERRY, FLORIDA

REVISIONS
ITEM: DELETE THICK EDGES AT SIDEWALKS
DATE: 04/04/11
07/11/11
VALUE ENGINEERING ITEMS

JOHN H. SOUTHARD

P.E. #57599

SHEET NO.

S.3.1