


ANY MODIFICATIONS TO THESE PLANS OR RE-USE OF THESE PLANS MUST BE APPROVED BY AND SIGNED BY THE ARCHITECT.

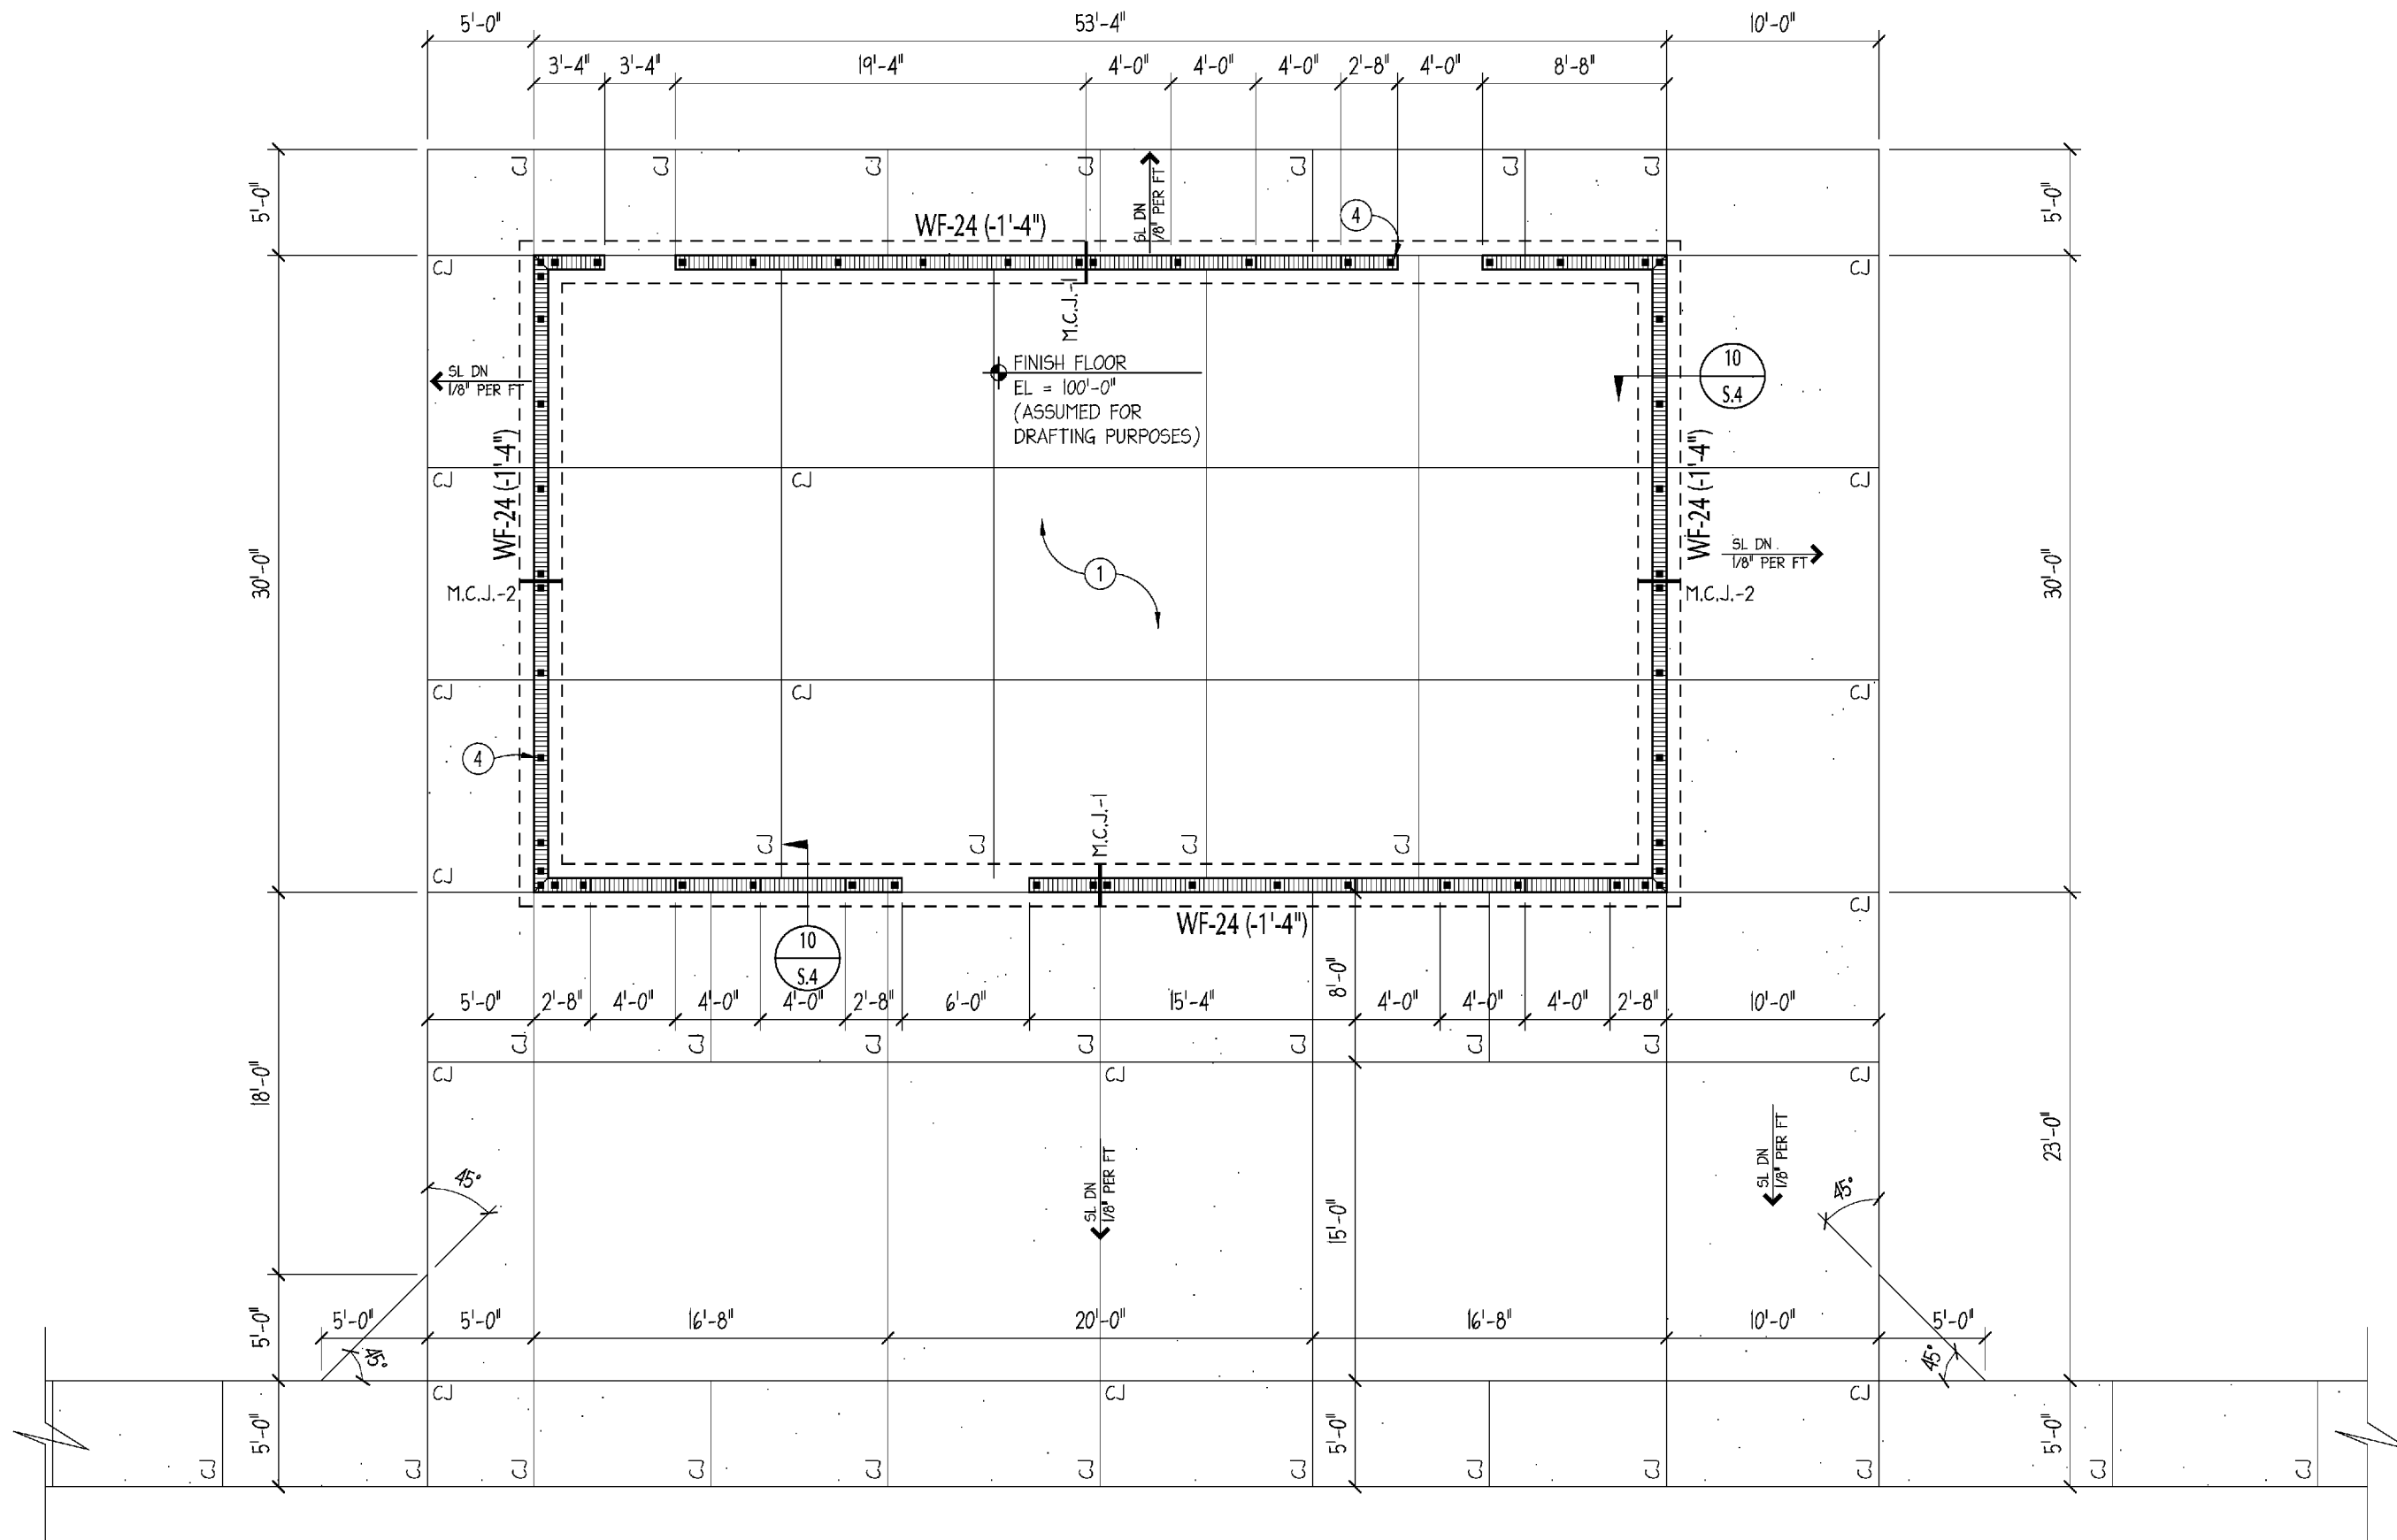


FOUNDATION PLAN

VOL ALT #03, ALT #08, ALT #09 & ALT #17

1/8" = 1'-0"

MAIN BUILDING

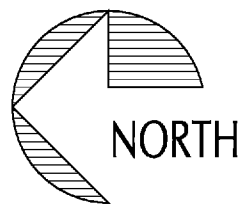

FOUNDATION PLAN NOTES

- 4" SLAB ON GRADE OVER PREPARED SUB-GRADE AS SPECIFIED. REINF. SLAB W/6X6-W/4XW/4 WIRE MESH @ CL OF SLAB. (OR USE FIBER REINFORCED CONC.) PROVIDE 6 MIL POLYETHYLENE BARRIER BETWEEN SLAB AND SUB-GRADE. (SUB-GRADE TO BE TERMIT TREATED).
- PROVIDE M.C.J. PER PLAN 3/4" GROOVE THROUGH TB/BOND B1 @ C.J. COORD. SEE DETAIL 4/5.6.
- REFER TO 2/5.4 FOR CONTROL JOINT INFO FOR SLAB ON GRADE.
- TYP 8" C.M.U. WALL REINF. W/ (1) #6 @ 48" O.C. VERT. (UNO). USE LADDER TYPE REINFORCING IN BED JOINTS @ 16" O.C. PER G.N. UNO. ONE #6 BAR @ ALL CORNERS & SIDES OF ALL OPENINGS.
- USE T5-16 FOR INTERIOR NON-LOAD BEARING WALLS U.N.O.
- SEE 4/5.4 FOR TYPICAL REINFORCEMENT DETAILS AT INTERSECTIONS OF FOOTINGS, BOND BEAMS, & TIE BEAMS.
- INTERIOR WALLS SHALL BE WOVEN TOGETHER AT INTERSECTIONS. SEE 2/5.6 FOR BOND BEAM REINF. AT TOP OF WALL. PLACE A BB-8 AT TOP OF ALL NON-LOAD BEARING WALLS.
- 2X6 SPP#2 @ 12" OC BLOCKED @ 3'-0" VERT.
- NOT USED.
- AT NON-LOAD BEARING INTERIOR C.M.U. WALLS, USE A CASTCRETE 8/8-08 OVER ALL 3'-4" DOOR OPENINGS.
- NOT USED.

REVISIONS	
DATE:	ITEM:
04/04/11	DELETE THICK EDGES AT SIDEWALKS
07/11/11	VALUE ENGINEERING ITEMS

JOHN H. SOUTHARD

P.E. #57599

SHEET NO.

S.2.1

CITY OF NEWBERRY
NATIONS BASEBALL PARK
NEWBERRY, FLORIDA

PAUL
STRESING
ASSOCIATES
INC.
ARCHITECTURE
INTERIOR DESIGN

SOUTHARD ENGINEERING, INC.

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DRAWN BY:
JMA/CSH
DATE:
02/17/11
PROJECT NO:
10-422